# **GENERAL NOTES:**

DIG ALERT (811) IS TO BE CONTACTED AND MUST COMPLY WITH EXCAVATION SAFETY IN ACCORDANCE WITH GOVERNMENT CODE 4216 WILL BE FOLLOWED PRIOR TO ANY EXCAVATION TAKING PLACE.

ACKNOWLEDGEMENT OF OWNER OR CONTRACTOR REPRESENTING OWNER

# SHEET INDEX

TITLE SHEET TS SITE/ ROOF PLAN SP A1.0 EXISTING/ PROPOSED FLOOR PLAN

SHEET NO. | SHEET DESCRIPTION

A2.0 PROPOSED ELEVATIONS PRIOR TO COMMENCEMENT OF WORK, IT'S OWNER'S/ CONTRACTOR RESPONSIBILITY TO VERIFY ALL PROPERTY LINES.

A PROFESSIONAL SURVEYOR IS RECOMMENDED IF OWNER/ CONTRACTOR CAN NOT DETERMINE SUCH PROPERTY LINE.

DESIGNER/ ENGINEER SHOULD BE CONTACTED AND NOTIFIED OF ANY DISCREPANCIES PRIOR TO COMMENCEMENT OF WORK.

# LOT DATA

PARCEL ID/ APN NO: 7503-028-004

LOT SIZE: 4,326 SQ.FT.

REDONDO BEACH LEGAL DESCRIPTION: LOT 3 BLK 148

STORY:

CONSTRUCTION TYPE: V-B

R-3 **ZONING:** 

OCCUPANCY GROUP: R-3/U

NO SPRINKLERS:

# SCOPE OF WORK

\*PROPOSED 300 SQ.FT ADDITION TO EXISTING SINGLE FAMILY DWELLING.

> -ADDITION CONSISTING OF NEW MASTER BEDROOM, BATHROOM, & WALK IN CLOSET.

\*PROPOSED 137 SQ.FT. DECK ATTACHED TO NEW ADDITION.

\*NO CHANGES TO GRADING/ LANDSCAPE/ HARDSCAPE

# KENSON RESIDENCE

# 305 N. FRANCISCA AVE REDONDO BEACH, CA 90277

# PROJECT SUMMARY

**EXISTING RESIDENCE** 

808 SQ.FT. 305 N. FRANCISCA AVE:

300 SQ.FT. PROPOSED ADDITION:

TOTAL AREA: 1,108 SQ.FT.

PROPOSED DECK: 137 SQ.FT.

**EXISTING PORCH** 

305 N. FRANCISCA AVE: 84 SQ.FT.

**EXISTING GARAGE** 

305 N. FRANCISCA AVE: 289 SQ.FT. ATTACHMENT A

BEST MANAGEMENT PRACTICES FOR CONSTRUCTION ACTIVITIES\*

Storm Water Pollution Control Requirements for Construction Activities Minimum Water Quality Protection Requirements for All Development Construction Projects/Certification Statement

The following is intended as minimum notes or as an attachment for building and grading plans and represent the minimum standards of good housekeeping that must be implemented on all construction sites regardless of size. (Applies to all permits)

• Eroded sediments and other pollutants must be retained on site and may not be transported from the site via sheetflow, swales, area drains, natural drainage courses or wind. • Stockpiles of earth and other construction related materials must be protected from being transported from

the site by the forces of wind or water. • Fuels, oils, solvents and other toxic materials must be stored in accordance with their listing and are not to contaminate the soil and surface waters. All approved storage containers are to be protected from the weather. Spills must be cleaned up immediately and disposed of in a proper manner. Spills may not be

• Non-stormwater runoff from equipment and vehicle washing and any other activity shall be contained at the

• Excess or waste concrete may not be washed into the public way or any other drainage system. Provisions shall be made to retain concrete wastes on site until they can be disposed of as solid waste. • Trash and construction related solid wastes must be deposited into a covered receptacle to prevent contamination of rainwater and dispersal by wind.

• Sediments and other materials may not be tracked from the site by vehicle traffic. The construction entrance roadways must be stabilized so as to inhibit sediments from being deposited into the public way. Accidental depositions must be swept up immediately and may not be washed down by rain or other


· Any slopes with disturbed soils or denuded of vegetation must be stabilized so as to inhibit erosion by wind

As the project owner or authorized agent of the owner, I have read and understand the requirements listed above, necessary to control storm water pollution from sediments, erosion, and construction materials, and I certify that I will comply with these requirements.


(Owner or authorized agent of the owner)

(Owner or authorized agent of the owner)

# VICINITY MAP

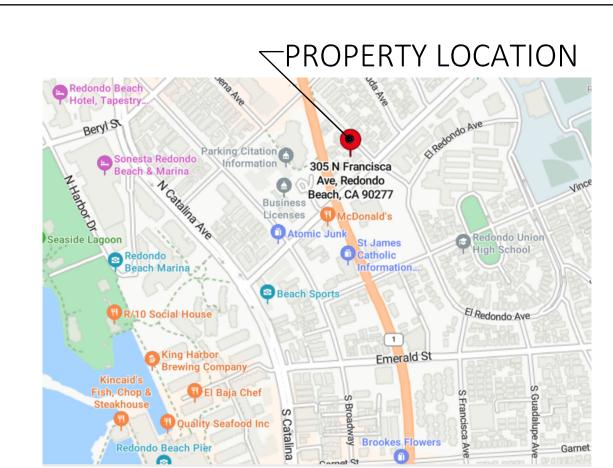

# PARCEL MAP

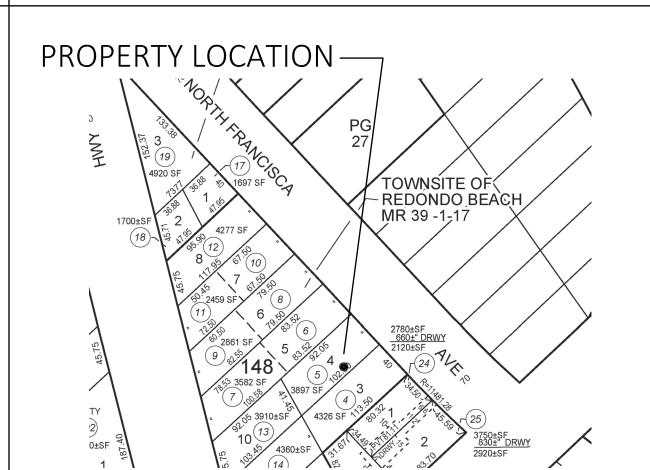

# CONSULTANTS

OWNERS NAME: KIM KENSON

305 N. FRANCISCA AVE REDONDO BEACH, CA 90277

ARCHITECTURAL

& STRUCTURAL **ENGINEERING:** 

JOSE C RAMIREZ, P.E.

RAMIREZ STRUCTURAL INC. (562) 519-6045

# **BUILDING CODES**

APPLICANT/ DEVELOPER SHALL COMPLY WITH APPLICABLE PROVISIONS OF:

2022 CALIFORNIA RESIDENTIAL CODE 2022 CALIFORNIA BUILDING CODE 2022 CALIFORNIA PLUMBING CODE 2022 CALIFORNIA ELECTRICAL CODE 2022 CALIFORNIA MECHANICAL CODE

2022 CALIFORNIA FIRE CODE

2022 CALIFORNIA GREEN BUILDING CODE

2022 CALIFORNIA ENERGY CODE

W/ CITY OF REDONDO BEACH AMENDMENTS

# RAMIREZ STRUCTURAL INC

JOSE RAMIREZ, PE jose@ramirezstructural.com (562) 519-6045 ig: @ramirezstructural www.ramirezstructural.com





Z

KEN

Q

300


AVE A 90277 Z Ш CISC, ACH, AN( BE/ 305 N. FR. RENDONDO


PROJECT NO. 24-233 DATE: 08/07/24

REVISION DESCRIPTION DATE

TS TITLE SHEET


SCALE: NONE

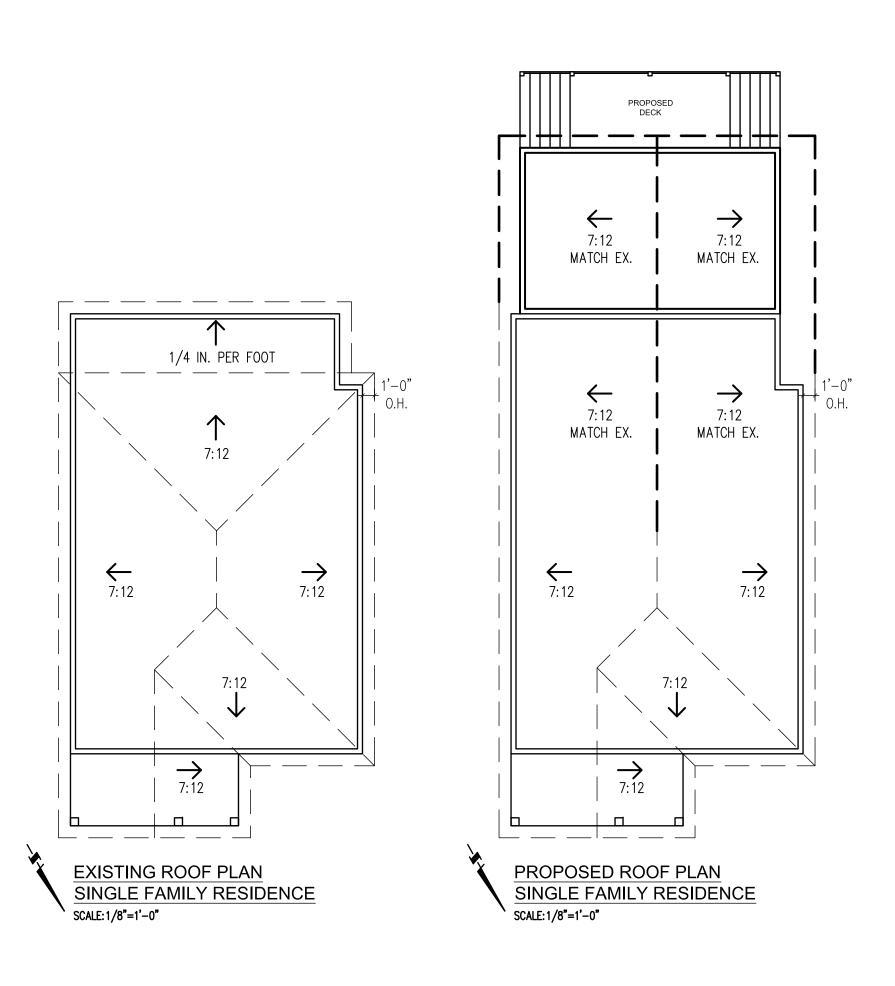

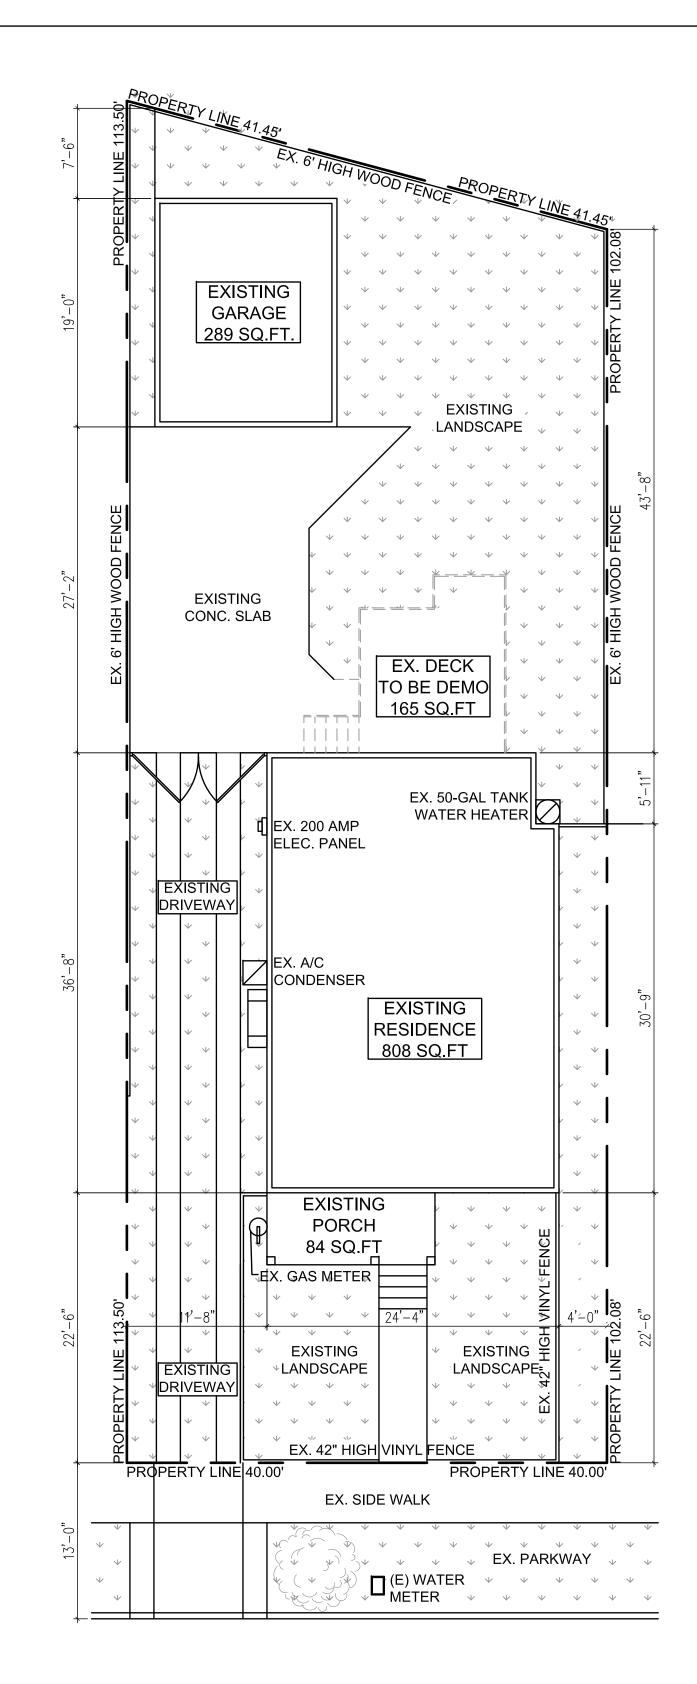

EXISTING SITE PLAN
SCALE: 1/8"=1'

305 N. FRANCISCA AVE

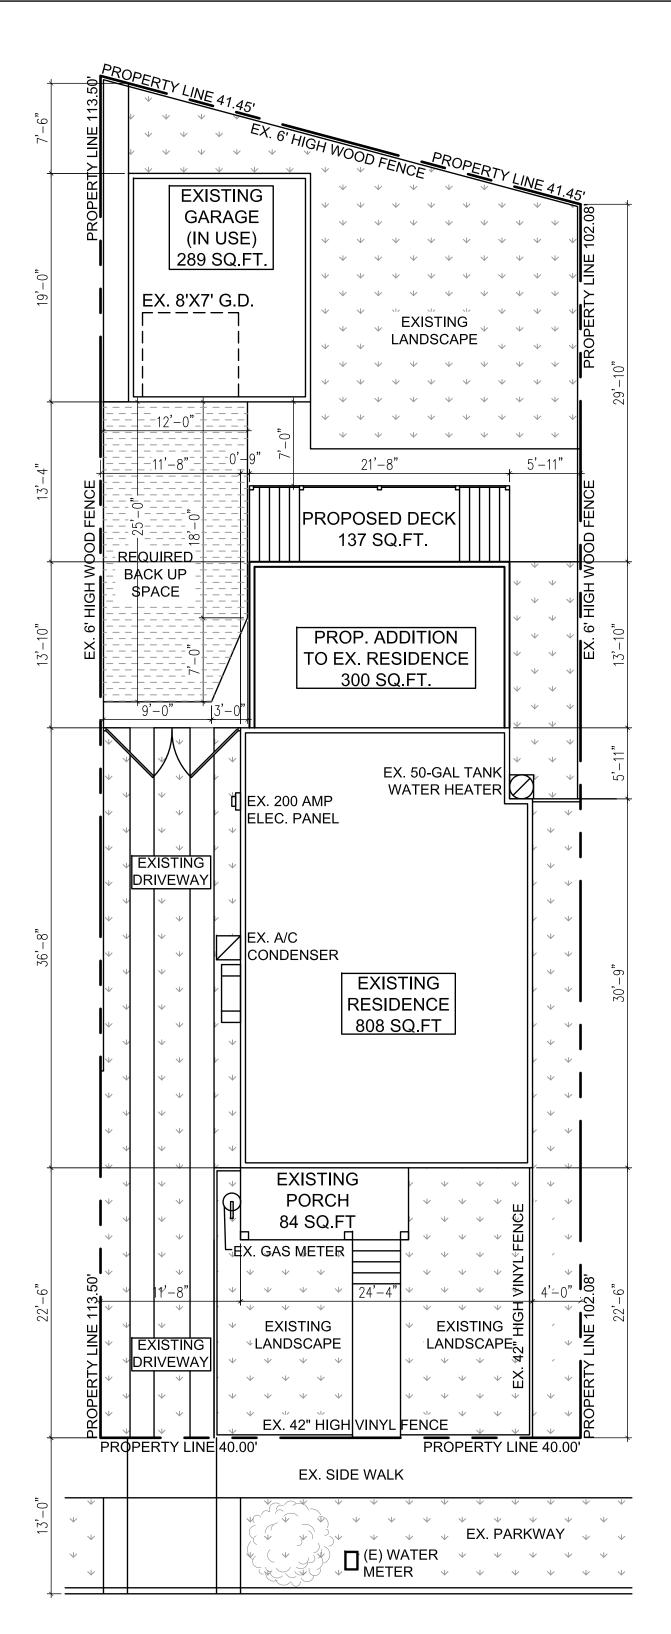

PROPOSED SITE PLAN

SCALE: 1/8"=1'

E: 1/8"=1'

305 N. FRANCISCA AVE

# RAMIREZ STRUCTURAL INC

JOSE RAMIREZ, PE
jose@ramirezstructural.com
(562) 519-6045
ig: @ramirezstructural
www.ramirezstructural.com





# KENSON RESIDENCE (N) 300 SQ.FT. ADDITION W/ 300 SQ.FT. OPEN DECK ABC 305 N. FRANCISCA AVE RENDONDO BEACH, CA 90277


PROJECT NO. 24-233


DATE: 08/07/24


REVISION	DESCRIPTION	DATE
A		
B		

SP SITE PLAN

SCALE: 1/8"=1'

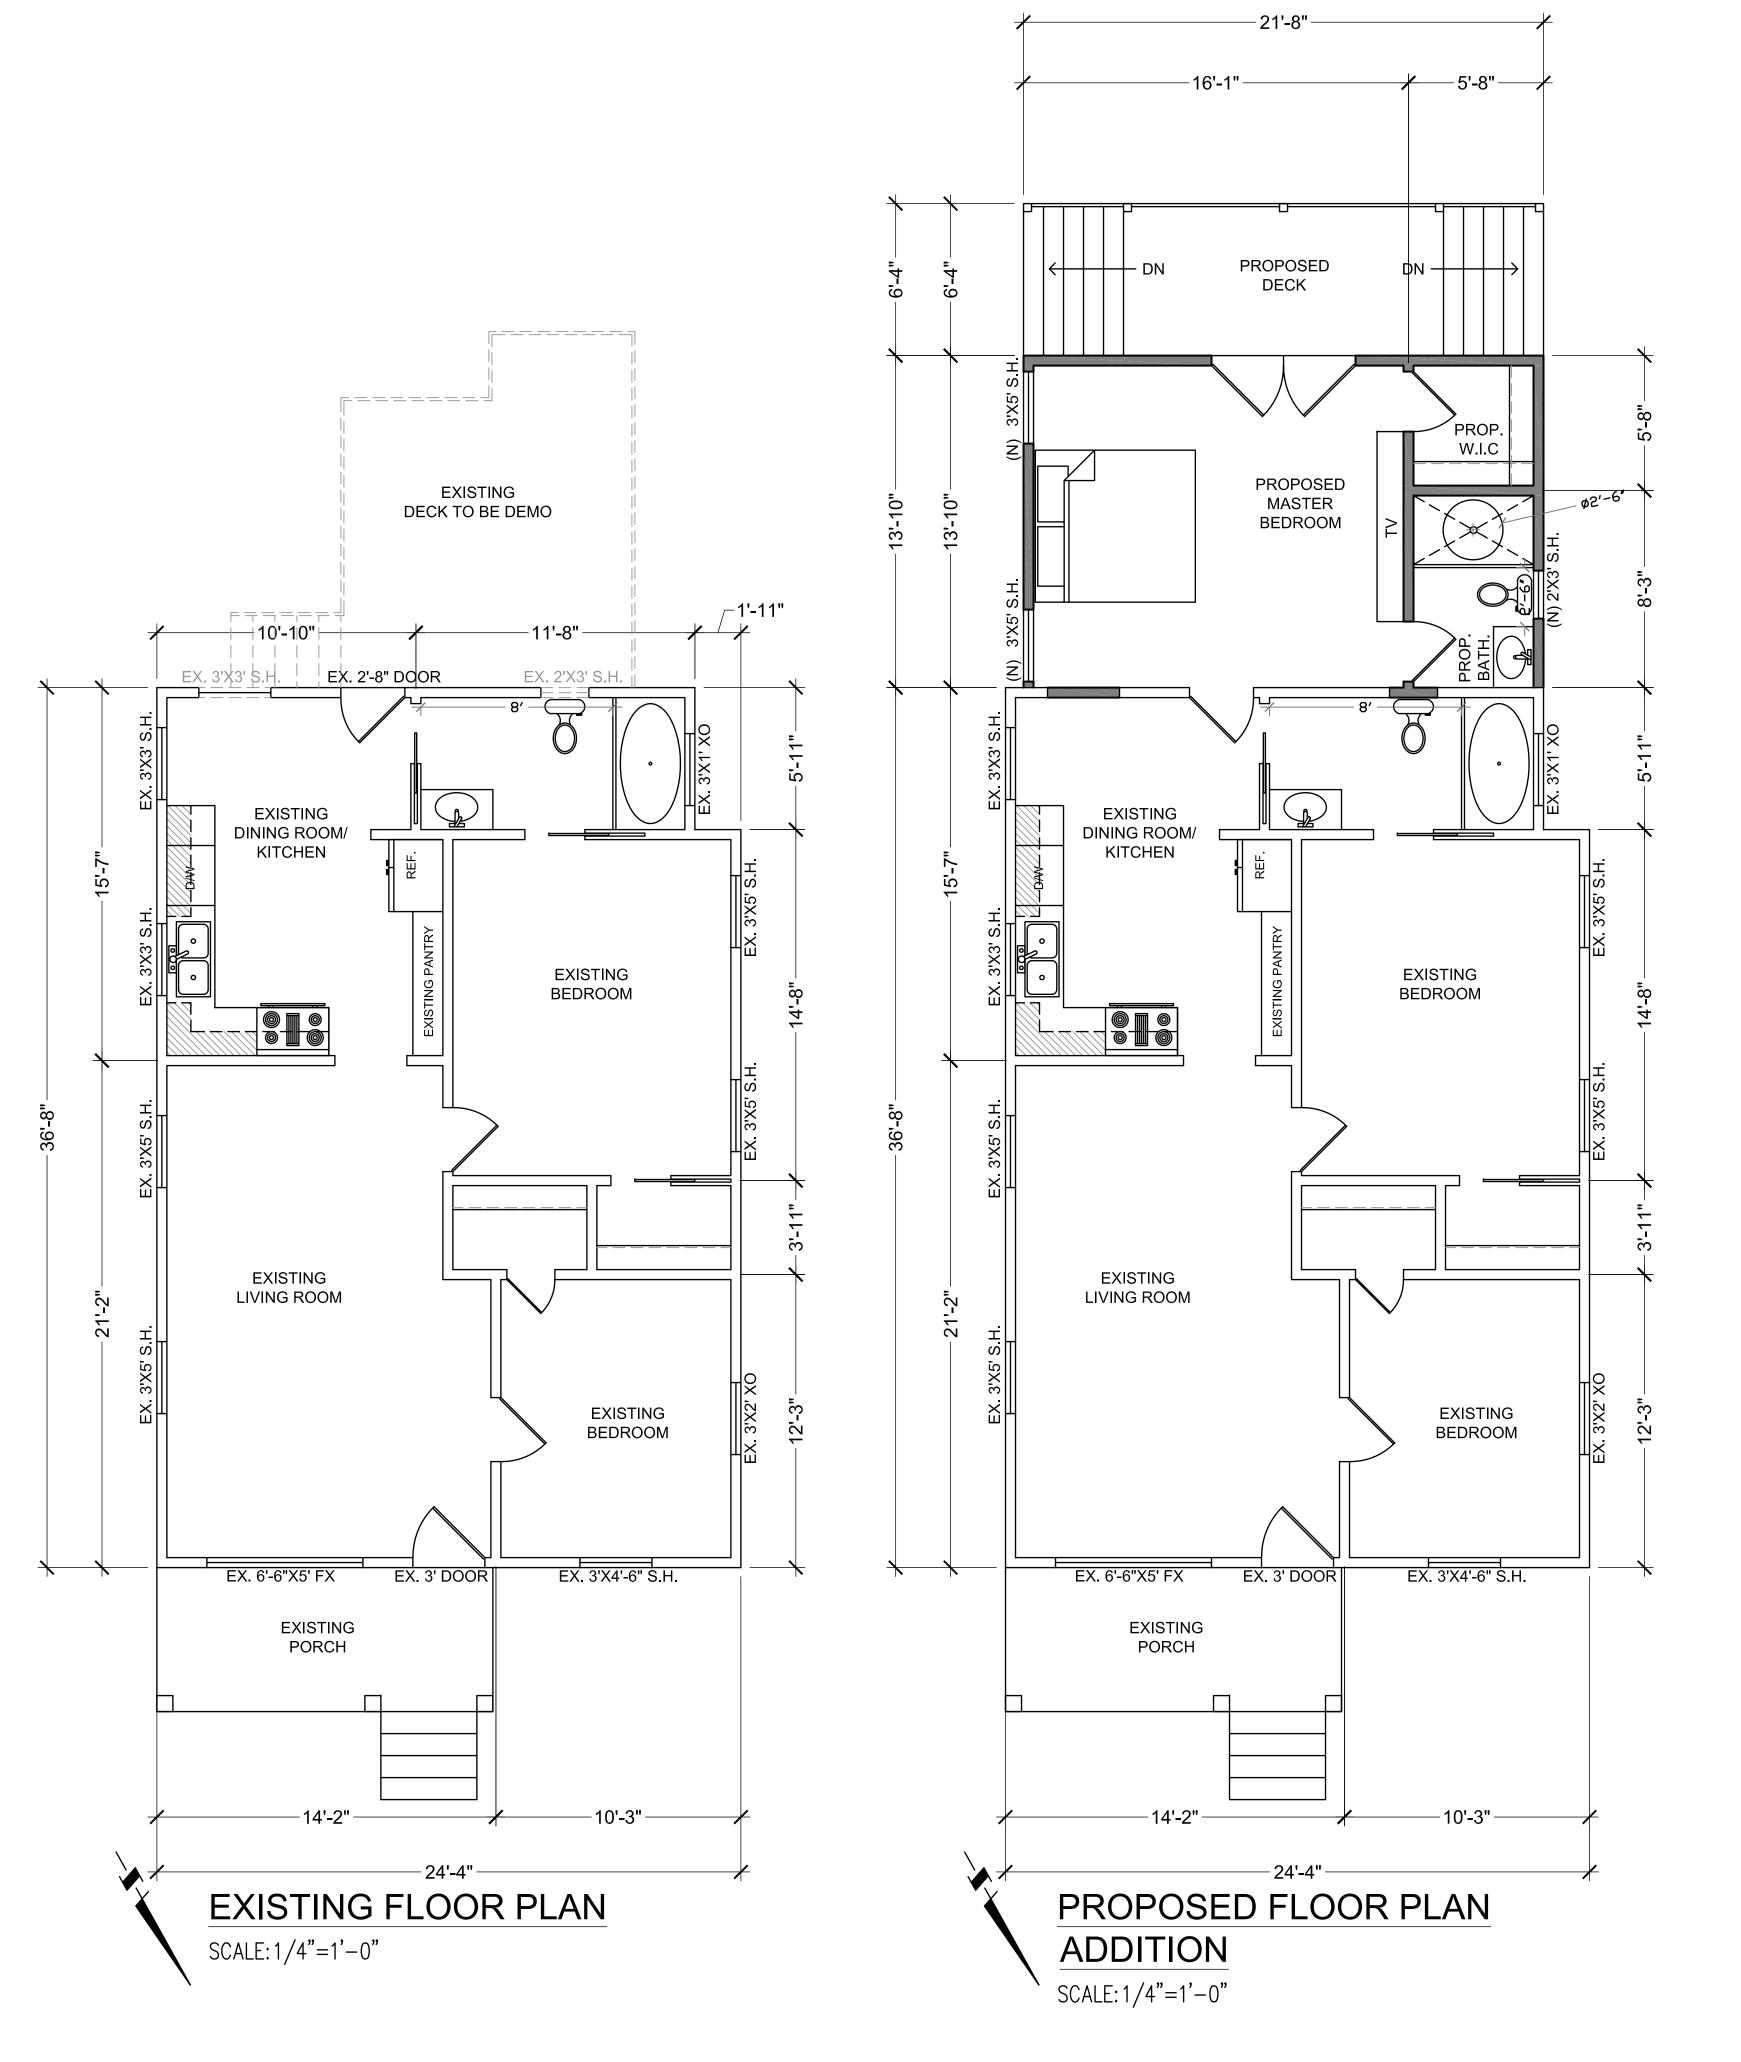

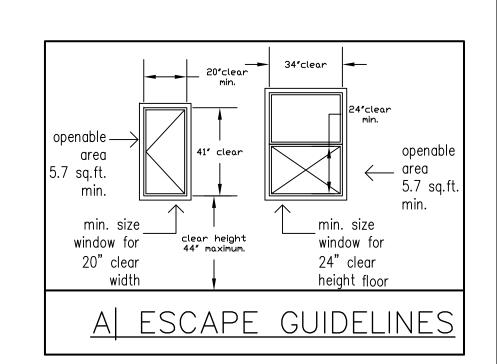

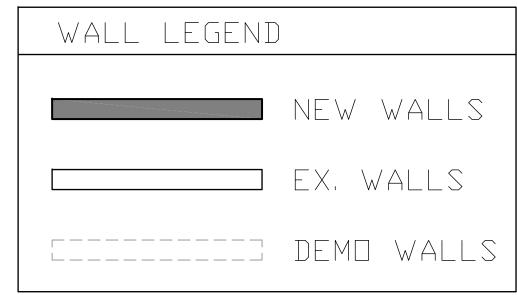

# RAMIREZ STRUCTURAL INC

JOSE RAMIREZ, PE
jose@ramirezstructural.com
(562) 519-6045
ig: @ramirezstructural
www.ramirezstructural.com





KENSON RESIDENCE
(N) 300 SQ.FT. ADDITION V
(N) 300 SQ.FT. OPEN DECK AE
305 N. FRANCISCA AVE
RENDONDO BEACH, CA 90277

PROJECT NO. 24-233


DATE: 08/07/24


REVISION	DESCRIPTION	DATE
A		
B		

A1.0

EX./ PROP. FLOOR PLAN

SCALE: 1/4"=1'

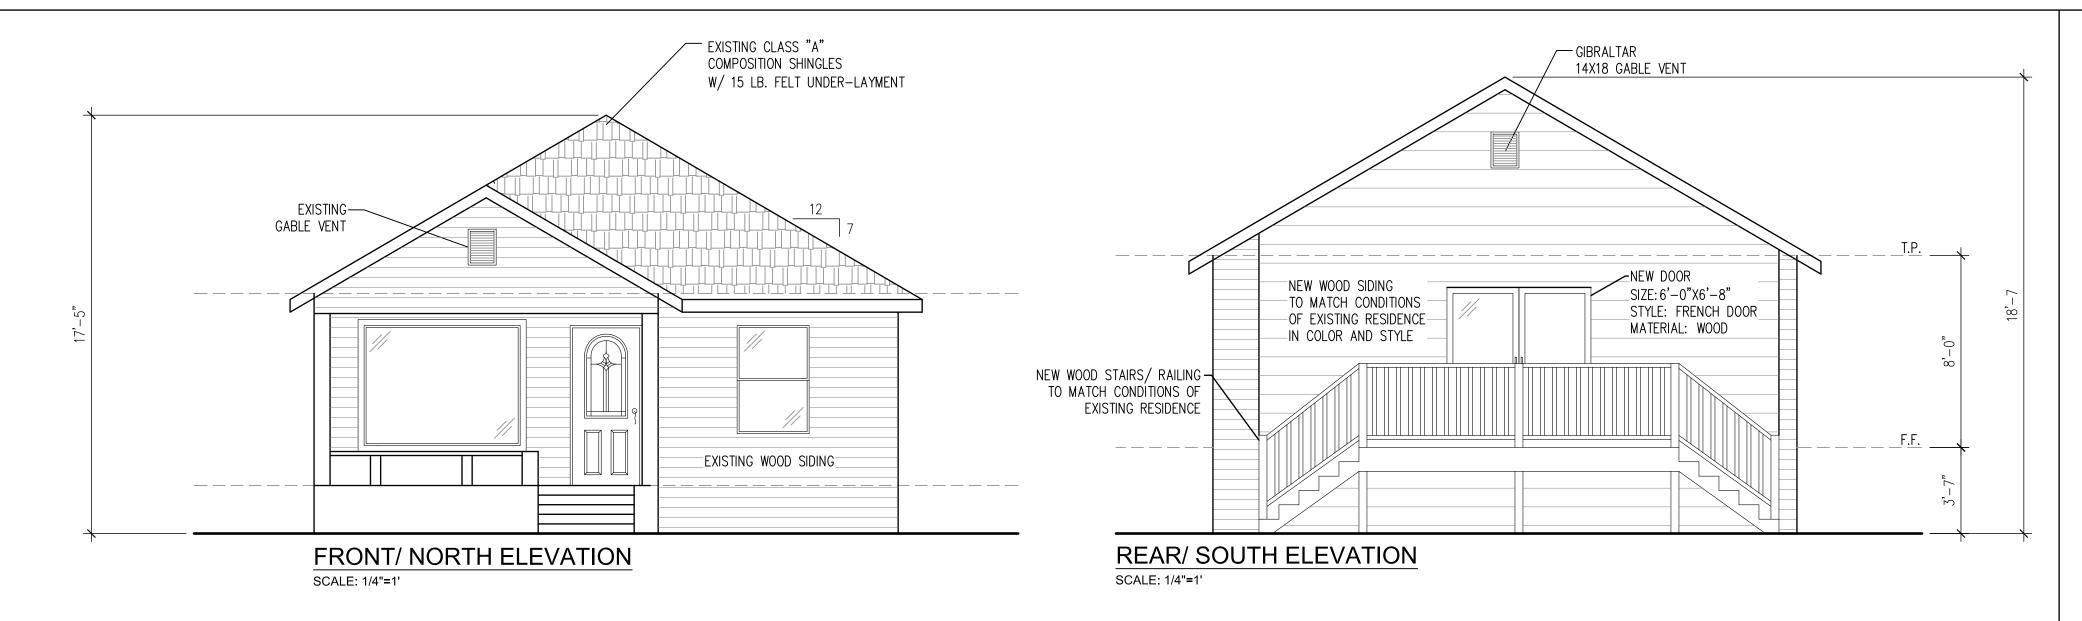

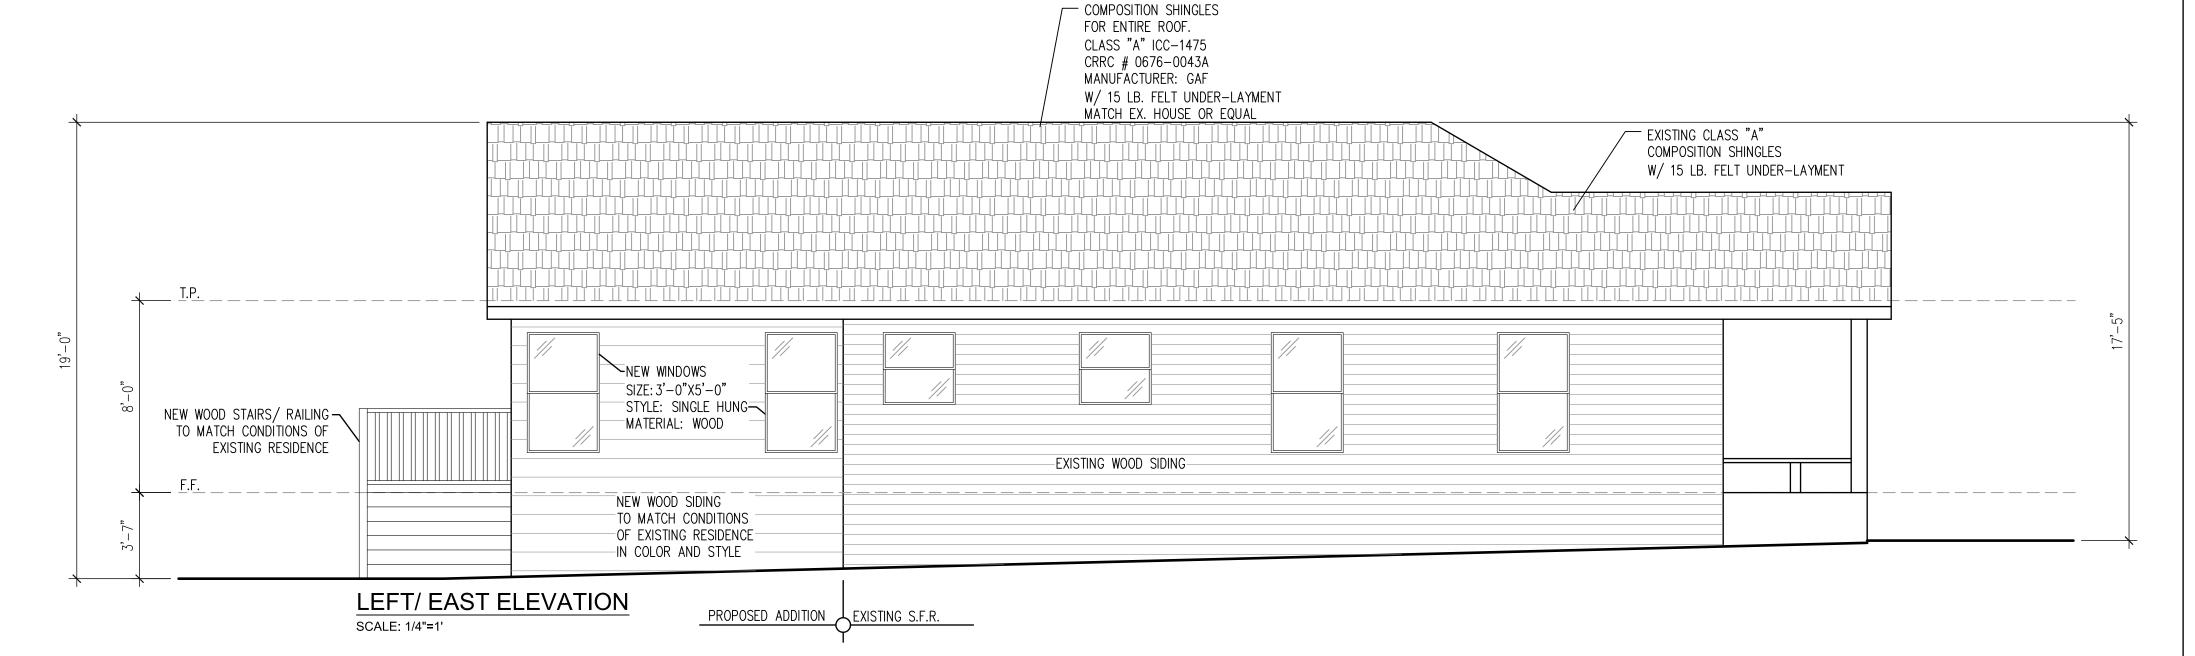

# RADIANT BARRIER

\*RADIANT BARRIER: THE RADIANT BARRIER SHALL HAVE AN EMITTANCE VALUE OF LESS THAN OR EQUAL TO 0.05 AND BE INSTALLED IN THE UPPER PORTION OF THE BUILDING'S TRUSS/RAFTERS, COVERING THE ENTIRE ROOF/ATTIC (INCLUDING ALL GABLE END), WITH THE REFLECTIVE SURFACE FACING DOWN TOWARD THE ATTIC.

WOOD FRAMING MEMBERS THAT REST ON CONCRETE OR MASONRY EXTERIOR FOUNDATION LESS THAN 8 INCHES FROM EXPOSED EARTH SHALL BE OF NATURALLY DURABLE OR PRESERVATIVE-TREATED WOOD.

REQUIRE DRIP EDGE AT EAVES AND RAKE EDGES OF SHINGLE ROOF PER R 905.2.8.5.

# VENTILATION:

ATTIC VENTILATION NEEDS TO BE AT LEAST 1/150 OF THE AREA WITH 50% REQUIRED VENTING LOCATED AT LEAST 3 ABOVE EAVE OR CORNICE VENTS WITH THE BALANCE OF REQUIRED VENTING PROVIDED BY EAVES OR CORNICE VENTS AND SHALL HAVE CROSS VENTILATION FOR EACH SEPARATE SPACE. THE AREA OF VENTILATION MAY BE REDUCED TO 1/300 PROVIDED A VAPOR RETARDER IS INSTALLED ON THE WARM SIDE OF THE ATTIC INSULATION. (2022 CBC)

# EXTERIOR FINISHES


ALL EXPOSE PLYWOOD TO BE EXTERIOR GRADE. ALL EXPOSE TRIM AND PLYWOOD TO BE RESAWN.

## ROOF NOTES

ROOF SHEATHING TO BE 1/2" PLYWOOD SHEATHING W/ 1 X SOLID SHEATHING AT ALL OVERHANGS.

# ROOF COVERINGS SHALL BE MIN. CLASS 'A' ASSEMBLY

TYPICAL ROOF OVERHANG AT RAKE CONDITION TO BE 12" UNLESS NOTED OTHERWISE ON PLAN EXTERIOR LATH: PROVIDE TWO LAYERS OF GRADE D PAPER OVER ALL WOOD BASE SHEATING.

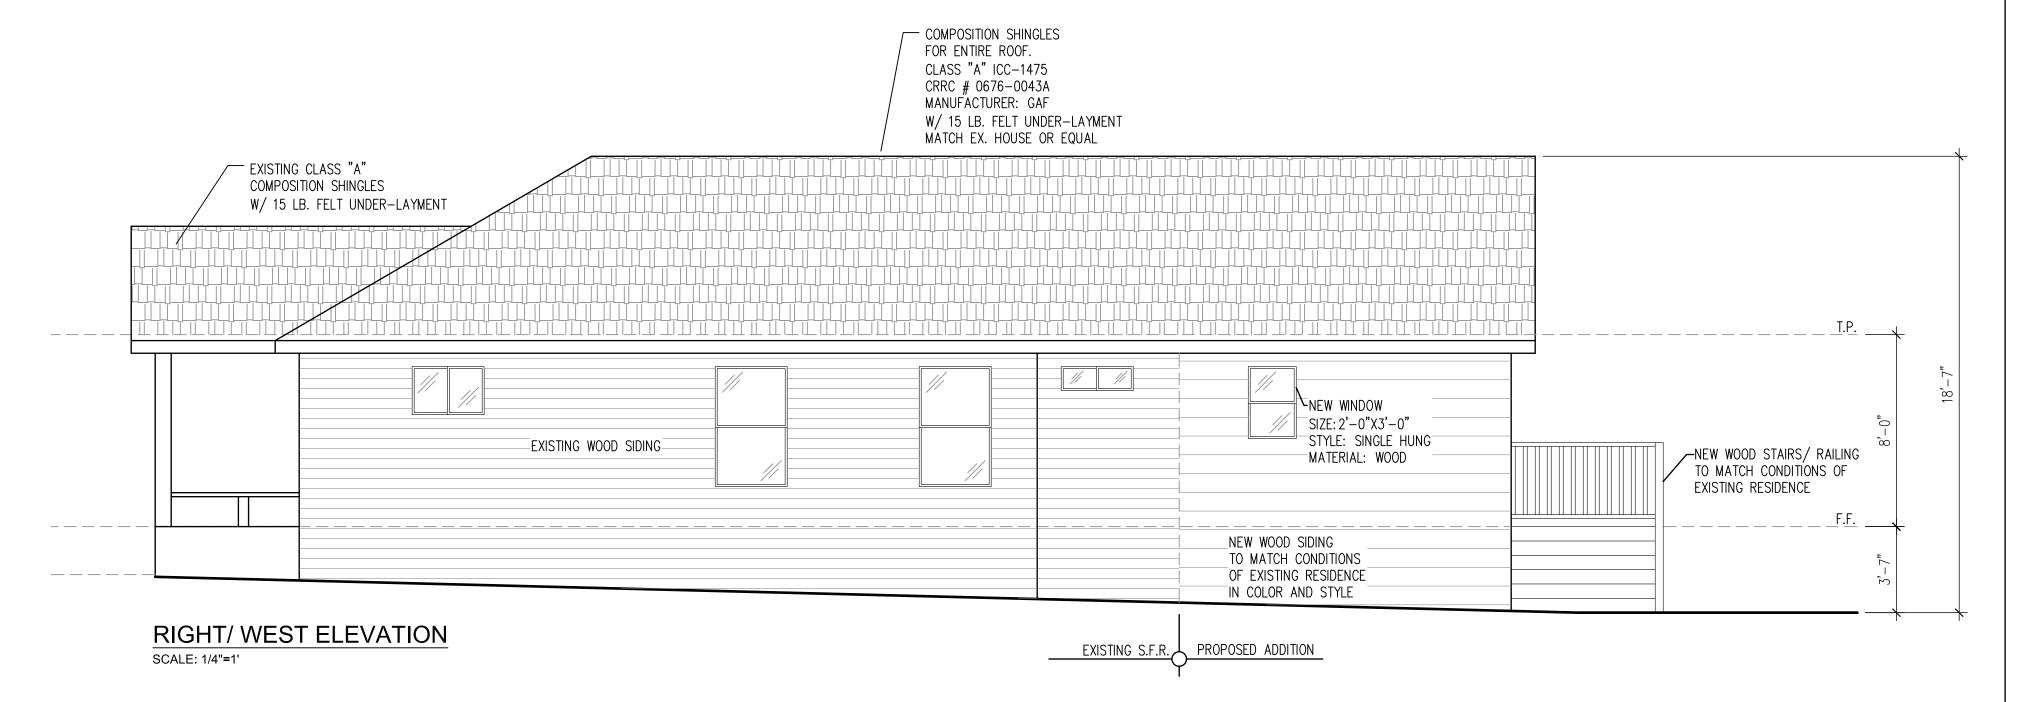

# RAMIREZ STRUCTURAL INC

JOSE RAMIREZ, PE jose@ramirezstructural.com (562) 519-6045 ig: @ramirezstructural www.ramirezstructural.com





N O Q KEN 300 (N)

RANCISC, BEACH,

305 N. FRARENDONDO E

PROJECT NO. 24-233

DATE: 08/07/24

REVISION DESCRIPTION DATE

PROPOSED **ELEVATIONS** 

SCALE: 1/4"=1'